# CITY OF TAMPA MOBILITY DEPARTMENT

## CONTRACT PLANS


FINANCIAL PROJECT ID 439476-4-58-02


### INDEX OF LANDSCAPE PLANS

LD-15 TO LD-18 PLANTING DETAILS

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E/W GREEN SPINE CYCLE TRACK -PH. 3C FROM 13TH AVE. TO 21ST. AVE.



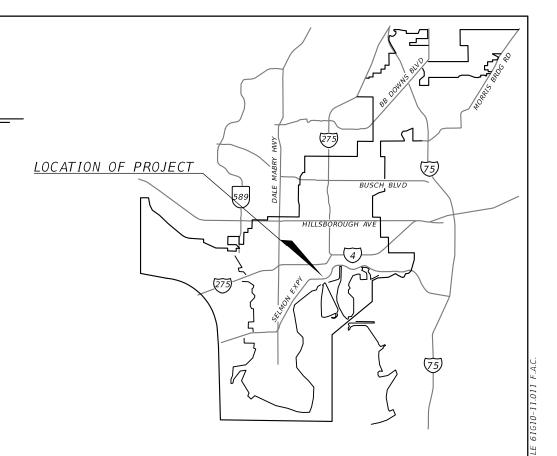

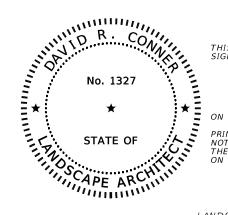FINAL SUBMITTAL

September 27, 2021

THIS ITEM HAS BEEN DIGITALLY SIGNED AND SEALED BY:

ON THE DATE ADJACENT TO THE SEAL

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LANDSCAPE PLANS LANDSCAPE ARCHITECT OF RECORD: DAVID CONNER

R.L.A. NO.: 1327

DAVID CONNER + ASSOCIATES

100 EAST MADISON STREET, STE 200

TAMPA, FL, 33602

813-258-1997

CONTRACT NO.: 21-C-00022

VENDOR NO.: 59-3421586

CERTIFICATE OF AUTHORIZATION NO.: LC0000319

CITY OF TAMPA PROJECT MANAGER:

NINA S. MABILLEAU E.I.

CONSTRUCTION CONTRACT NO.	FISCAL YEAR	SHEET NO.	
21-C-00022		LD-1	

### 15TH ST FROM 13TH AVE TO 21ST AVE

PAY ITEM NO.	DESCRIPTION	UNIT	FINAL
520-2-4	CONCRETE CURB, TYPE D	LF	160
580-1-1	LANDSCAPE COMPLETE (SMALL PLANTS)	LS	1
580-1-2	LANDSCAPE COMPLETE (LARGE PLANTS)	LS	1
COT-101	PAVERS, ARCHITECTURAL, SIDEWALK	SY	87
COT-102	PRE-EMERGENT HERBICIDE	SY	142
COT-103	FURNISHINGS	LS	1

PERFORMANCE TURF IS INCLUDED AND PAID FOR IN THE ROADWAY PLANS PAY ITEMS.

REVISIONS DAVID R. CONNER, RLA LA0001327 CITY OF TAMPA DESCRIPTION MOBILITY DEPARTMENT DAVID CONNER + ASSOCIATES 100 E. MADISON ST, SUITE 200 ROAD NO. COUNTY TAMPA, FL 33602 CERT. OF AUTHORIZATION LC0000319 HILLSBOROUGH

FINANCIAL PROJECT ID

SUMMARY OF PAY ITEMS

LD-2

#### LANDSCAPE TABULATION OF QUANTITIES / PLANT SCHEDULE

#### 15TH ST FROM 13TH AVE TO 21ST AVE

PAY ITEM	SYM	BOTANICAL NAME	COMMON NAME	INSTALLED	MAXIMUM MAINTAINED	CRACING	REMARKS	UNIT		SHEET	NUMBER		TOTAL THIS			AND TAL
NO.		BOTANICAL NAME	COMMON NAME	SIZE	SIZE	SPACING	NEMARKS	UNII	LD-7 /	LD - 13	LD-8 /	′ LD-14	SHI	EET	, ,	, , , L
									PLAN	FINAL	PLAN	FINAL	PLAN	FINAL	PLAN	FINAL
520 - 2 - 4		CONCRETE CURB, TYPE D						LF	144		16		160		160	
580 - 1 - 1		LANDSCAPE COMPLETE (SMALL PLANTS)						LS	·				7		1	
360-1-1	ZAM PUM	ZAMIA PUMILA	COONT I E	3 GALLON	18" Ht.	36 O.C.		EA	138		17		155		1	
580 - 1 - 2		LANDSCAPE COMPLETE (LARGE PLANTS)						L5	•				1		1	
	SAB PAL	SABAL PALMETTO	SABAL PALM	B&B			14' CT. HT.; MAINTAIN A MIN 8' VERTICAL CLEARANCE OVER SIDEWALKS; REGENERATED ROOT	EA	3		2		5			
	QUE CAT	QUERCUS VIRGINIANA 'CATHEDRAL'	CATHERDAL LIVE OAK	B&B			6 CAL; 20' HT X 10' SP; RPG TREES WITH SPREADING CHARACTER AND MINIMAL INTERAL GROWTH. NO TIP PRUNING. NO OPEN WOUNDS. 7' CLEAR TRUNK	EA	3				3			
		PREPARED SOIL LAYER						SY	126		16		142			
		BIO BARRIER						LF	68				68			
COT - 101		PAVERS, ARCHITECTURAL, SIDEWALK						SY	69		18		87		87	
COT - 102		PRE-EMERGENT HERBICIDE						SY	126		16		142		142	
COT - 103		FURNISHINGS						LS					1		1	
		BENCH							1		1		2			
		BICYCLE RACK							2				2			
		BIKE MAINTENANCE STATION							1				1			
		LITTER RECEPTACLE							1	***************************************	1		2			
PAY ITEM NO		PASPALUM NOTATUM 'ARGENTINE'	BAHAI GRASS	SOD			PERFORMANCE TURF IS PROV PERFORMANCE TURF QUANTIT							MS .		make de manufaceasa and marcola.

SUMMARY OF PAY ITEMS

520-2-4, CONCRETE CURB, TYPE D

CONCRETE CURB SHALL BE MODIFIED PER HARDSCAPE DETAIL SHEET LD-9

580-1-1, LANDSCAPE COMPLETE, SMALL PLANTS INCLUDES:

- 1. PREPARATION OF PLANTING BEDS INCLUDING EXCAVATION OF EXISTING SOIL OR TURF AS DESCRIBED IN THE PLANS AND SPECIAL DETAILS.
- 2. COLLECTION AND APPROVAL OF PROPOSED PLANTS BY ENGINEER PRIOR TO DELIVERY TO THE PROJECT SITE.
- DELIVERY AND HOLDING OF PLANTS IN PREPARATION OF INSTALLATION.
- INSTALLATION OF PLANTS INCLUDING EXCAVATION OF SOILS FOR PLANTING, INCORPORATION OF SOIL AMENDMENTS, FERTILIZATION, PLACEMENT AND BACKFILLING OF SOIL, PLACEMENT OF MULCH AND ANY OTHER REQUIREMENTS COMMON TO THE WORK OR AS DESCRIBED IN THE SPECIFICATIONS.
- 5. 90 DAY ESTABLISHMENT WATERING AND MAINTENANCE PER PLANT ESTABLISHMENT PLAN.

#### 580-1-2, LANDSCAPE COMPLETE, LARGE PLANTS INCLUDES:

- COLLECTION AND APPROVAL OF PROPOSED PLANTS BY ENGINEER PRIOR TO DELIVERY TO THE PROJECT SITE.
- DELIVERY AND HOLDING OF PLANTS IN PREPARATION OF INSTALLATION
- 3. INSTALLATION AND STAKING OF PLANTS AS CITY OF TAMPA STANDARDS OR AS DESCRIBED IN THE SPECIAL DETAILS
- 4. ORGANIC MULCH APPLIED AROUND THE BASE OF CANOPY TREES AND SHRUBS AS

INDICATED ON PLANS LD-13 AND LD-14

- 5. SABLE PALM CHARACTER PALMS (SPC)
  - a. CHARACTER PALMS WILL BE SELECTED AND TAGGED BY THE ENGINEER PRIOR TO DELIVERY TO SITE.
- 6. PREPARED SOIL LAYER
  - a. PREPARED SOIL LAYER SHALL BE A FINISH SOIL LAYER
  - b. THE DEPTH OF THE FINISH SOIL SHALL BE PER PLANTING DETAILS NOTED IN LD-15 TO LD-18. THE AREA (CY) OF SOIL INCLUDE THE AVERAGE DEPTH OF SOIL AS DETERMINED BY THE HEIGHTS OF PLANTING AREAS.
- 7. BIO BARRIER
- a. TYPAR: 24"
- b. REFER TO HARDSCAPE DETAIL ON LD-10 FOR INSTALLATION
- 8. 90 DAY ESTABLISHMENT WATERING AND MAINTENANCE PER PLANT ESTABLISHMENT PLAN.

#### COT-101, PAVERS, ARCHITECTURAL SIDEWALK

- 1. PAVERS SHALL BE SUPPLIED FROM THE COT STOCKYARD
  - a. IF PAVERS ARE NOT AVAILABLE FROM THE STOCKYARD, THE CONTRACTOR WILL BE REQUIRED TO PROVIDE SAMPLES OF ALTERNATIVE PAVERS SIMILAR IN APPEARANCE TO HISTORIC PAVERS COMMON TO TAMPA, AND RECEIVE CITY APPROVAL PRIOR TO PURCHASE.
- 2. PAY ITEMS INCLUDES INSTALLATION AND BASE MATERIALS

#### COT-102. PRE-EMERGENT HERBICIDE

- 1. PRE-EMERGENT HERBICIDE: RONSTAR G. HERBICIDE, 50LB BAG
- 2. APPLY PRIOR TO MULCHING
- 3. APPLY AT TREE RING OF EACH TREE
- 4. APPLY AT RATES RECOMMENDED BY THE MANUFACTURER WITH THE AREAS OF NEW PLANTING BEDS

#### COT-103, FURNISHINGS

- 1. BENCH: VICTOR STANLEY; CLASSIC SERIES; MODEL NO. CR-138; 6'; COLOR: BLACK: INTERMEDIATE ARMRESTS (CENTER)
- 2. BIKE RACK: FAIR WEATHER SITE FURNISHINGS: MODEL NO. B-1500 (SURFACE MOUNT), COLOR: BLACK
- 3. BIKE MAINTENANCE STATION WITH AIR PUMP: THE PARK CATALOG: ITEM NO.: 509-2001-134; COLOR: BLACK
- 4. LITTER RECEPTACLE: VICTOR STANLEY; IRONSITES COLLECTION; MODEL NO. SD-42; 36 GALLON; COLOR: BLACK - POWDERCOAT

	REVIS	5 I O N S		DAVID R. CONNER, RLA	CITY	OF TAMPA TRANSP	ORTATION AND
DATE	DESCRIPTION	DATE	DESCRIPTION	LA0001327		MWATER SERVICES	
				DAVID CONNER + ASSOCIATES   100 E. MADISON ST, SUITE 200	ROAD NO.	COUNTY	FINANCIAL PROJECT ID
				TAMPA, FL 33602 CERT. OF AUTHORIZATION LC0000319		HILLSBOROUGH	

TABULATION OF QUANTITIES AND PLANT SCHEDULE

LD-3

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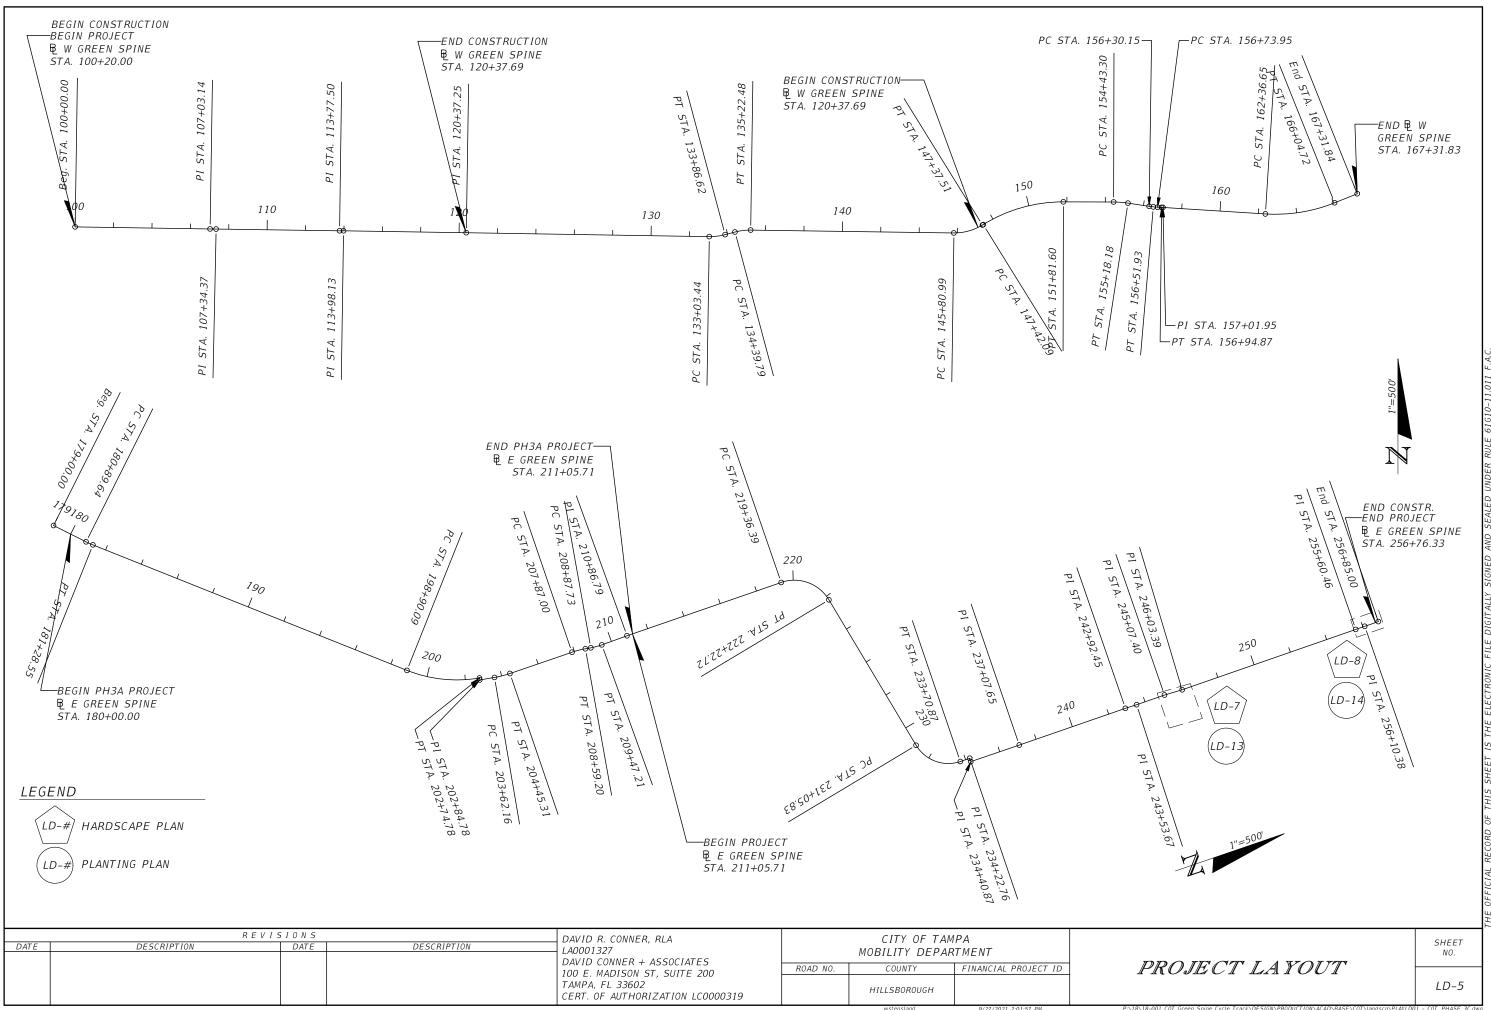
	PLANT EST							DAYS								
OPERATION	90 DAY ESTABLISHMENT PERIOD TO BE PROVIDED BY CONTRACTOR AS PART OF PAY ITEMS 580-1-1 AND 580-1-2.							CITY	OF TAMP	A COMMIT	MENT ON	YEARLY	CYCLE			
WEEK	1 2 3 4	5678	9 - 12		JAN	FEB	MAR	APR	MAY	JUNE	JULY	AUG	SEPT	OCT	NOV	DEC
WATERING # DAYS	7777	4 4 4 4	2													
			ALL WATE DROUGHT						DAY CON	TRACTED	MAINTEN	ANCE PEF	RIOD			
NEEDING/LITTER PICK UP	1 TIME EACH 1 TIME EACH 2 1 TIME EACH 2 WEEK WEEK PERIOD WEEK PERIOD				(GLYPHO APPLICA	SATE) OR TOR OR U	EQUAL AI NDER TH	PPLIED / E SUPER	NT THE R VISION C	ATE OF 1 F LICENS	1/2 OZ.	PER GAL	CIDE SUCH LON AND LITTER PI	APPLIED	BY LICEN	ISED
	CONTRACTOR SHALL WEED AND PICK UP LITTER IN ALL PLANTING BEDS AND INDIVIDUAL TREE WELLS ONCE IN EACH FOUR WEEK PERIOD BEFORE THE END OF THE 90 DAY ESTABLISHMENT PERIOD.			PERFURI	MED PRIO	K TU APP	LICATON	OF HERE	SICIDE.							
PRUNING		MECHANICALLY R HALL MAINTAIN ST ACCEPTANCE.											AND/OR LO		HEARS. S	HRUBS
FERTILIZING	· '	SHRUBS AND GRO HEN PLANTED PER				PLAMS AN CATIONS.	D GROUN	DCOVERS	MUST B	E FERTIL	IZED ANI	NUALLY P	PER MANUF	ACTURE	R' <i>S</i>	
MOWING	EVERY 14 DAYS	LEAVING 3" IN H	EIGHT.		EVERY 1	4 DAYS L	EAVING 3	" HEIGHT	Γ.							
EDGING	EVERY 14 DAYS	VERY 14 DAYS BY MECHNICAL MEANS.			EVERY 1	4 DAYS E	Y MECHN	ICAL MEA	ANS.							
MULCHING	EACH PLAN. SEL	MULCH SHALL BE APPLIED IMMEDIATELY AFTER WATERING OF EACH PLAN. SEE PLANTING PLANS AND SPECIFICATIONS FOR MULCH TYPES/DEPTH TO BE USED.			RESTORI	E 3" LAYE.	R MULCH	ONCE A	YEAR. SE	E PLANTI	NG PLANS	S FOR MU	JLCH TYPE	S TO BE	USED.	

WATER APPLICATION	RATES						
(FOR NON-IRRIGATED AREAS)	(FOR NON-IRRIGATED AREAS)						
TREES AND PALMS	SATURATE TO 3' DEPTH. FLOOD TREE						
TURF	REFER TO ROADWAY SPECIFICATIONS						
SMALL PLANTS	WATER EACH PLANT BY HAND. PROVIDE 2 GALLONS WATER PER PLANT						
NOTE:							
CONTRACTOR IS RESPONS	IBLE FOR WATER SOURCE AS PART OF PAY ITEM.						

FERTILIZER APPLICATION RATES							
TREES AND PALMS	FERTILIZER PER DETAILS AND MANF. SPECIFICATIONS SHALL BE APPLIED AT TIME OF PLANTING AND ONCE ANNUALLY.						
GROUNDCOVERS / GRASSES	FERTILIZER PER DETAILS AND MANF. SPECIFICATIONS SHALL BE APPLIED AT TIME OF PLANTING AND ONCE ANNUALLY.						

	REVIS	10N5		DAVID R. CONNER, RLA		CITY OF TAM	ΡΔ	
DATE	DESCRIPTION	DATE	DESCRIPTION	LA0001327 DAVID CONNER + ASSOCIATES		MOBILITY DEPAR		
				100 E. MADISON ST. SUITE 200	ROAD NO.	COUNTY	FINANCIAL PROJECT ID	1
				TAMPA, FL 33602 CERT. OF AUTHORIZATION LC0000319		HILLSBOROUGH		

PLANT ESTABLISHMENT PERIOD SHEET NO.



#### LANDSCAPING

- 1. THE BASELINE SHOWN IN THE PLANS IS FOR INFORMATION PURPOSE ONLY. THE BASELINE IS REFERENCED FROM PROJECT NO. 439476-1-58-01.
- 2. PERFORMANCE TURF INDICATED ON SHEETS LD-13 TO BE INCLUDED IN CIVIL PAY ITEM FOR PERFORMANCE SOD.
- 3. INSTALL SMALL PLANT ROOTBALLS A MINIMUM OF 2 FEET FROM UNDERGROUND UTILITIES.
- 4. DO NOT INSTALL LANDSCAPE MATERIALS THAT BLOCK TRAFFIC CONTROL SIGNS OR DEPARTMENT'S INFORMATIONAL OR LOGO SIGNS. ALL LANDSCAPE AREAS SHALL BE MAINTAINED TO PRESERVE VISIBILITY OF TRAFFIC CONTROL DEVICES AND SIGNS. RESET SIGNS DISTURBED DURING CONSTRUCTION TO CURRENT STANDARDS FOR HEIGHT, OFFSET, AND METHOD OF INSTALLATION AT THE CONTRACTOR'S EXPENSE.
- 5. SCHEDULE ALL ON-SITE PLANT DELIVERIES TO OCCUR ON MONDAY THROUGH FRIDAY ONLY UNLESS APPROVED BY THE ENGINEER IN ADVANCE. ENSURE THAT PLANT MATERIAL IS DELIVERED UNDAMAGED FROM TRANSPORTATION OR DIGGING OPERATIONS. THE ENGINEER MAY REJECT MATERIAL THAT HAS BEEN DAMAGED OR RENDERED UNACCEPTABLE DUE TO RELOCATION OR TRANSPORTATION FROM THE POINT OF ORIGIN. REPLACE DAMAGED PLANT MATERIAL AT NO ADDITIONAL EXPENSE TO THE DEPARTMENT.
- 6. "WATER IN" TREES AND PALMS LEAVING NO AIR POCKETS. FILL ANY AIR POCKETS WITH SOIL AND KEEP GRADE WITHIN TREE RING EVEN AND SMOOTH, MAINTAIN EROSION FREE TREE RINGS AND REPAIR AS NECESSARY PER PLANING DETAILS. WATER SOURCE AND APPLICATION OF WATER FOR THE SUCCESSFUL TRANSPLANT, ESTABLISHMENT, AND SURVIVAL OF PLANTS IS THE RESPONISBILITY OF THE CONTRACTOR AT NO ADDITIONAL EXPENSE TO THE CITY.
- 7. DURING PLANTING, APPLY A SLOW/CONTROLLED RELEASE 8-2-12+4 MG PALM FERTILIZER THAT INCLUDES IRON, MANGANESE AND BORON AS MINOR ELEMENTS, DISTRIBUTE THE FERTILIZER EVENLY OVER THE TOP OF THE PLANTING HOLE WITHIN THE SOIL RING AT A RATE SPECIFIED IN THE MANUFACTURER'S RECOMMENDED LABEL DIRECTIONS.
- 8. TRIMMING OF PALMS WILL BE LIMITED TO DEAD/BROWN FRONDS AND ANY LOOSELY ATTACHED DANGLING FRONDS, FRUITS, AND PETIOLES OR SPATHES UNLESS OTHERWISE DIRECTED BY THE ENGINEER.
- 9. MULCH MATERIAL SHALL EITHER INORGANIC (SHELL ROCK) OR ORGANIC (SHREDDED HARDWOOD) MULCH AS INDICATED ON THE PLANS AND PLACED THROUGHOUT ALL NEW PLANTING BEDS. MULCH SHALL COVER ALL EXPOSED SOIL WITHIN BEDS TO COMPRESSED DEPTH OF 3". DO NOT PLACE MULCH AGAINST TRUNK OF PLANTS OR TREES. DO NOT MULCH PERFORMANCE TURF.
- 10. THE ESTABLISHMENT PERIOD SHALL BE ONE YEAR FROM THE DATE OF FINAL ACCEPTANCE OF THE INSTALLATION OF THE TOTAL PROJECT.
- 11. ALL LANDSCAPE MATERIAL SHALL BE INSTALLED AND MAINTAINED AT ALL TIMES IN ACCORDANCE WITH THE FDOT STANDARDS INDEX 580 AS WELL AS ALL OTHER APPLICABLE CITY OF TAMPA STANDARDS. APPLY THE MORE STRINGENT STANDARDS WHERE CONFLICT OCCURS.
- 12. PROCEDURE (TOPIC NO, 850-000-015-I OF 01/01/2014), "ALL CONTRACTORS AND/OR PERMITTEE'S WHO CONTRACT THE APPLICATION OF FERTILIZER SHALL ENSURE THEY ARE LICENSED COMMERCIAL APPLICATORS WHO HAVE BEEN TRAINED THROUGH THE GREEN INDUSTRY BMP PROGRAM, AND HAVE OBTAINED A LIMITED CERTIFICATION FOR URBAN LANDSCAPE COMMERCIAL FERTILIZER APPLICATION UNDER SECTION 482.1562,F.S. WITH A CURRENT COPY OF THE LICENSE ON FILE.

13. THE EXISTING SIDEWALKS SHALL REMAIN AVAILABLE FOR SAFE USE THROUGHOUT THE PROJECT WITH ONLY PERIODIC CLOSURES AS APPROVED BY ENGINEER.

#### ROOT REGENERATED PALM REQUIREMENTS

- 1. ALL SABAL PALMS SHALL BE ROOT REGENERATED AND MEET THE FOLLOWING CRITERIA.
  - a. PALMS SHALL HAVE BEEN DUG AND REPLANTED IN CONTAINERS LOCATED WITHIN A NURSERY SPECIALIZING IN REGENERATED ROOT PALM TREE PRODUCTION.
  - b. PALM TREES SHALL HAVE BEEN PLANTED IN CONTAINERS AND HELD IN A NURSERY ENVIRONMENT FOR A MINIMUM OF 6 MONTHS. PRIOR TO DELIVERY TO THE PROJECT, ROOTBALL SHALL BE CONTAINED IN A STRETCH WRAP OR EQUIVALENT, FORMING A SOLID DURABLE ROOTBALL.
  - c. PRIOR TO DELIVERY TO THE PROJECT, PALMS ROOTS SHALL DEMONSTRATE SIGNIFICANT VISIBLE NEW REGENERATED ROOTS AT THE PERIMETER OF THE ROOT BALL.
  - d. PALM TREES SHALL DEMONSTRATE NEW GROWTH IN THE CANOPY INCLUDING FULLY EXTENDED AND OPEN FRONDS.
  - e. ALL PALM TREE LOADS SHALL BE TARPED TO PREVENT WIND DAMAGE DURING DELIVERY.
  - f. ALL PALM TREES SHALL BE INJECTED WITH 'TREE SAVER'
    (OXYTETRACYCLINE HYDROCHLORIDE 39% ACTIVE INGREDIENTS), A
    MINIMUM OF 1X PRIOR TO TRANSPLANTING, AND 1X 90 DAYS AFTER
    TRANSPLANTING. PROVIDE RECEIPTS TO ENGINEER.

#### SITE GRADING

- 1. AFTER ALL UTILITIES HAVE BEEN LOCATED, STAKE OUT THE SITE IMPROVEMENTS FOR FIELD INSPECTION BY THE ENGINEER.
- 2. TWO WEEKS PRIOR TO COMMENCEMENT OF GRADING WORK, APPLY ON-SELECTIVE HERBICIDE THROUGHOUT THE LIMITS OF GRADING WORK.
- 3. SHAPE SOILS TO FORM LANDSCAPE AREAS INDICATED.
- 4. USE IMPORTED SOIL SIMILAR IN COMPOSITION AND PERFORMANCE (ESPECIALLY RELATIVE TO DRAINAGE/PERCOLATION) TO THE IN-SITU MATERIAL AND MEET THE REQUIREMENTS OF SPECIFICATION SECTION 162-1.1 FINISHED SOIL LAYER.
- 5. PROPERLY DISPOSE OF ANY EXCESS SOIL.
- 6. EXISTING TOPOGRAPHIC SURVEY INFORMATION INDICATED ON THESE PLANS WAS PREPARED BY OTHERS UNDER A PREVIOUS CONTRACT AND IS PROVIDED FOR REFERENCE ONLY ON THIS PROJECT.
- 7. CONFIRM EXISTING ELEVATIONS ON SITE PRIOR TO BEGINNING ANY EXCAVATION OR GRADING WORK. ANY DEVIATIONS FROM THE PLANS SHALL BE APPROVED BY THE ENGINEER IN ADVANCE.

#### UTILITY

- 1. IN THE EVENT A DIRECT UTILITIES CONFLICT DOES ARISE, THE PROPOSED PLANTING CAN BE MOVED WITH PRIOR APPROVAL OF THE ENGINEER.
- 2. USE EXTREME CAUTION WHEN EXCAVATING, INSTALLING, BACKFILLING AND COMPACTING AROUND EXISTING UTILITIES.

DESIGN SPEEDS		
SEGMENT	DESIGN SPEED	POSTED SPEED
PHASE 3C (13TH AVE. TO 17TH AVE.)	30 MPH	25 MPH

#### LEGEND



EXISTING TREE



CONTROL JOINT
ISOLATION JOINT



*PAVERS* 



LITTER RECEPTACLE



BENCH

OFFICIAL RECORD OF THIS SHEET IS THE ELECTRONIC FILE DIGITALLY SIGNED AND SEAL

R E V I S I O N S

DATE DESCRIPTION DATE DESCRIPTION

DAVID R. CONNER, RLA
LA0001327
DAVID CONNER + ASSOCIATES
100 E. MADISON ST, SUITE 200
TAMPA, FL 33602
CERT. OF AUTHORIZATION LC0000319

CITY OF TAMPA
MOBILITY DEPARTMENT


ROAD NO. COUNTY FINANCIAL PROJECT ID


HILLSBOROUGH


GENERAL NOTES


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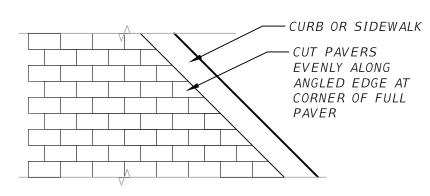
LD-6



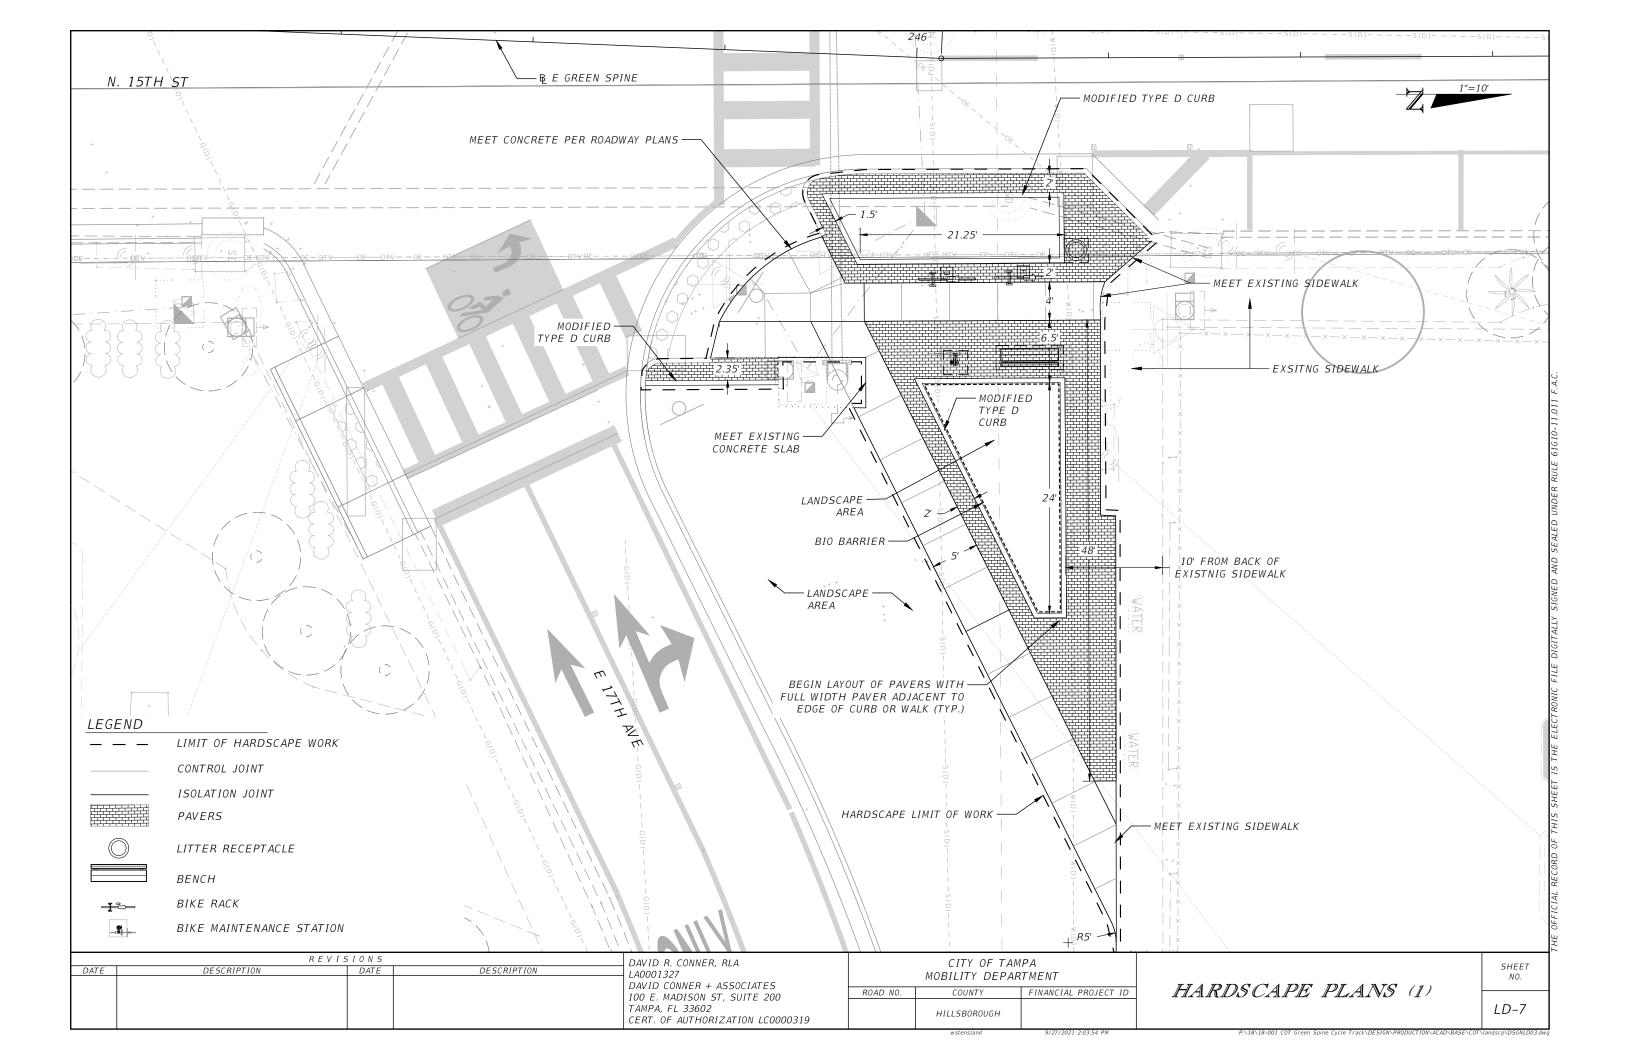

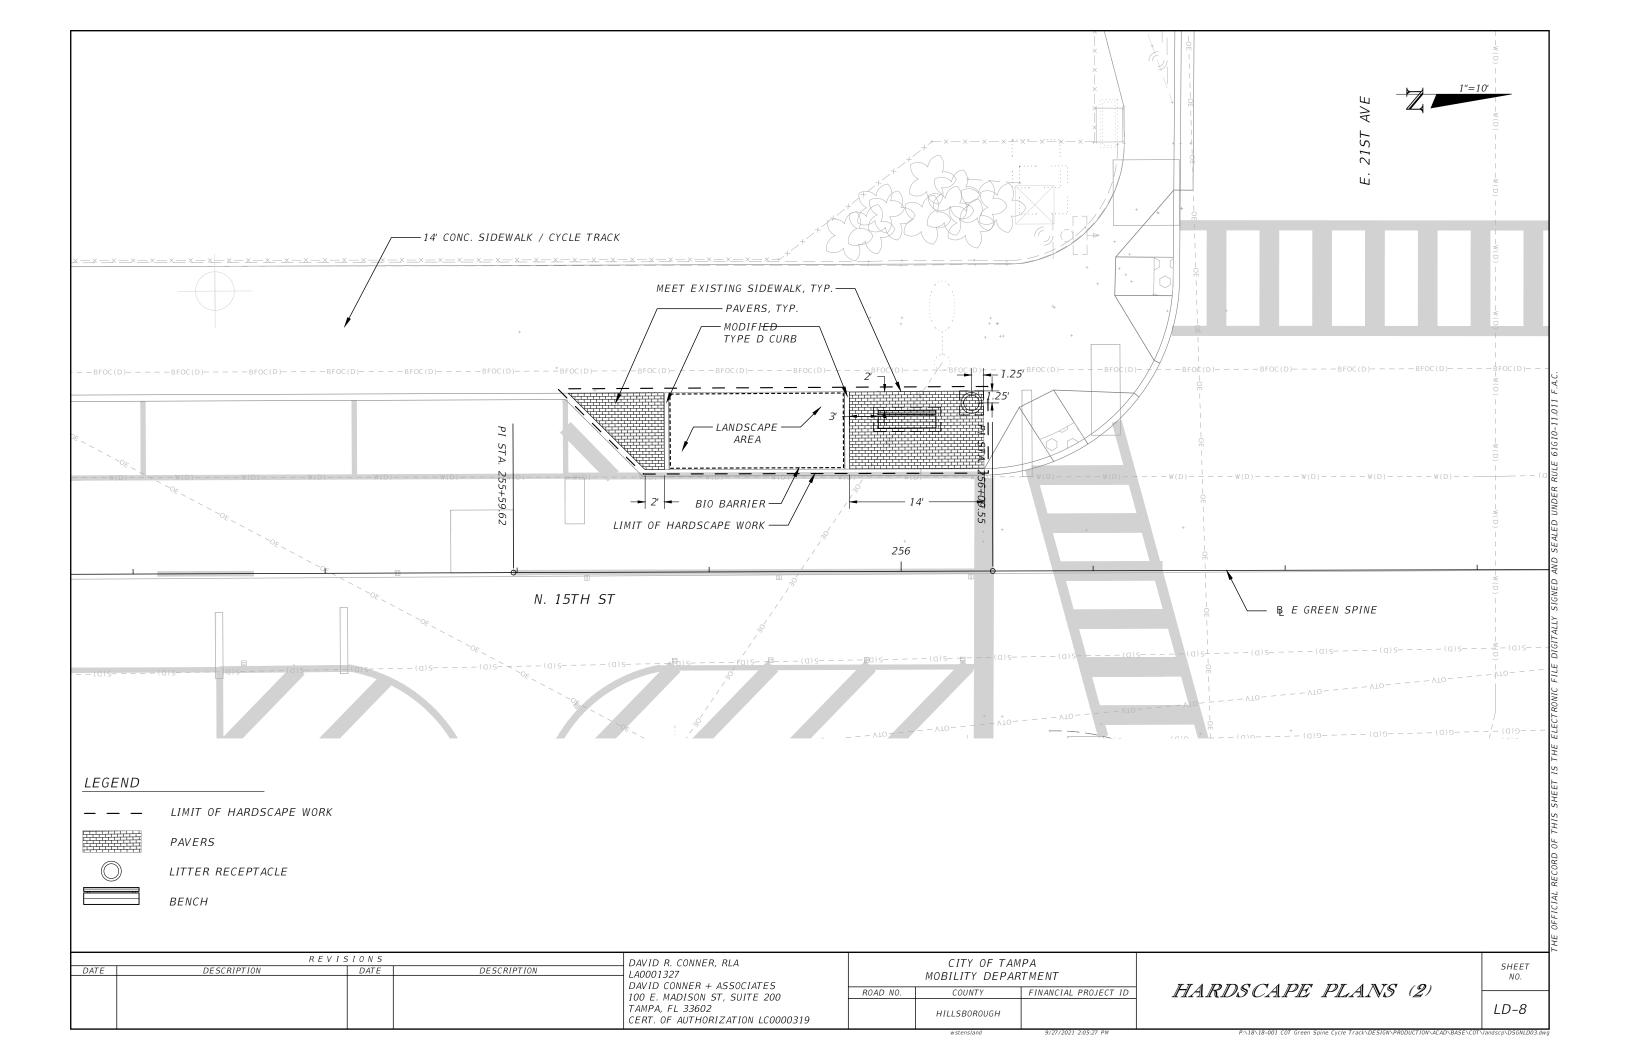

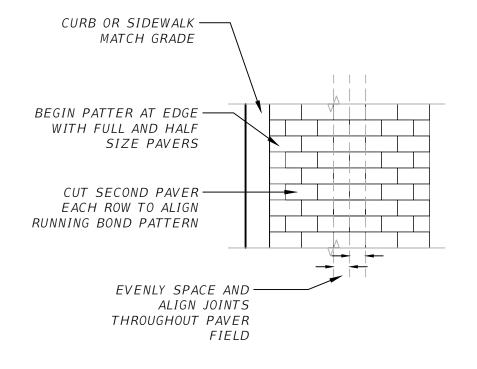

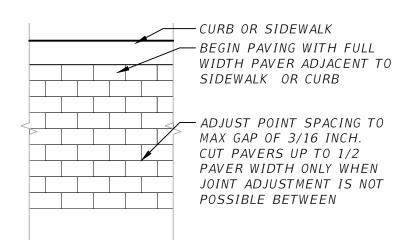

PERPENDICULAR TO CURB OR SIDEWALK

PARALLEL TO CURB OR SIDEWALK

PAVING AT MISALIGNED EDGE

(1)

DATE

UNIT PAVING PATTERN - RUNNING BOND

1/2'' = 1'-0

DESCRIPTION

REVISIONS

DAVID R. CONNER, RLA
LA0001327
DAVID CONNER + ASSOCIATES
100 E. MADISON ST, SUITE 200
TAMPA, FL 33602
CERT. OF AUTHORIZATION LC0000319

CITY
MOBILITY
ROAD NO. COUNT
TAMPA, FL 33602
CERT. OF AUTHORIZATION LC0000319

CITY OF TAMPA
MOBILITY DEPARTMENT

COUNTY FINANCIAL PROJECT ID

HILLSBOROUGH


HARDSCAPE DETAILS (1)

SHEET NO.

DCA-GR-29

LD-9


stensland 9/27/2021 2:0

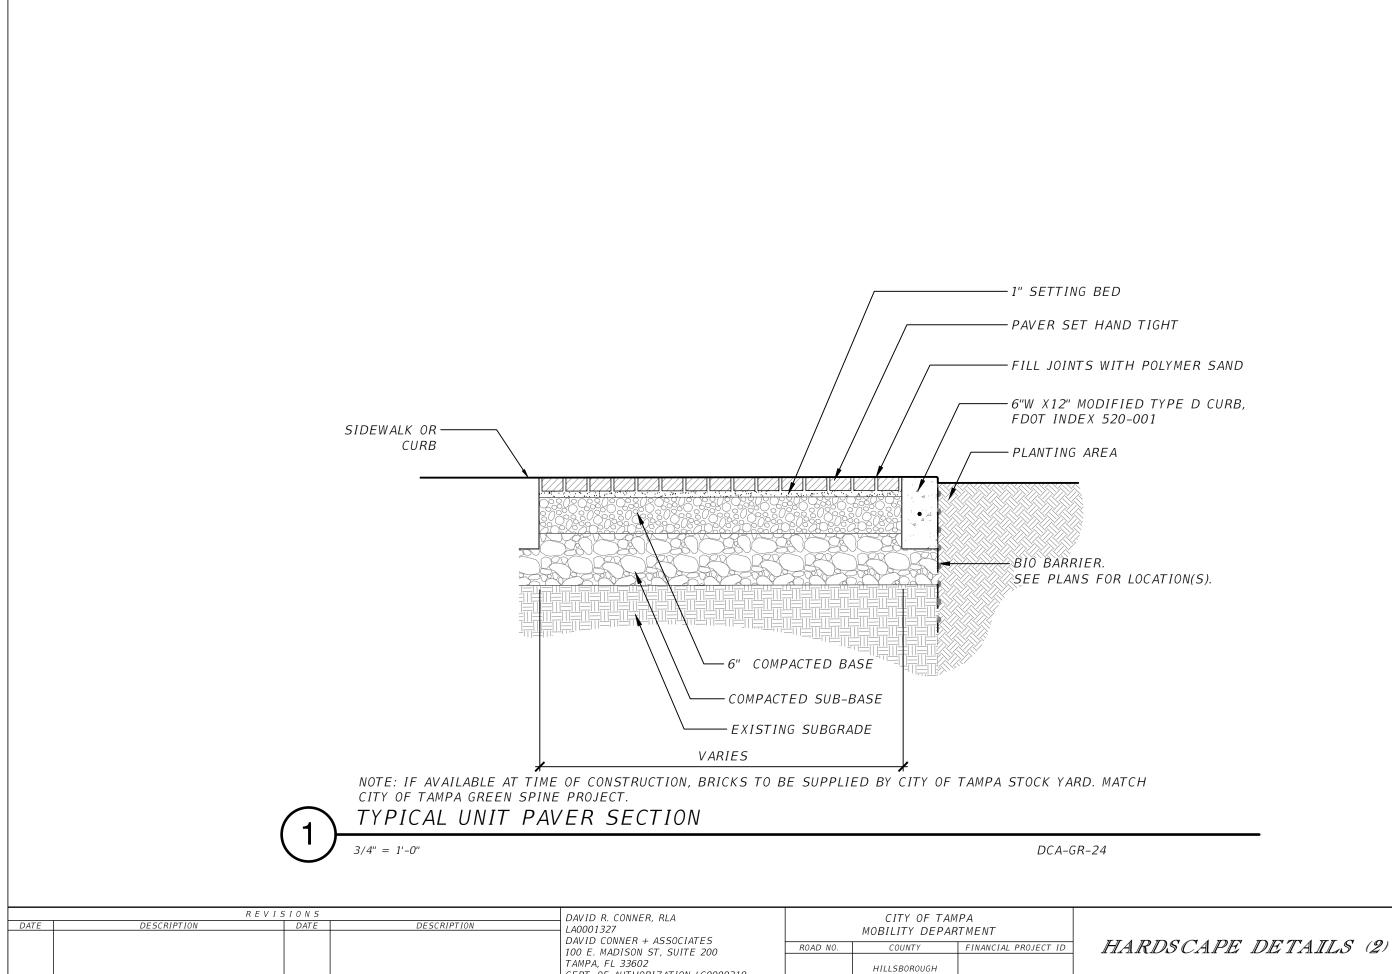


CERT. OF AUTHORIZATION LC0000319

LD-10

SHEET NO.

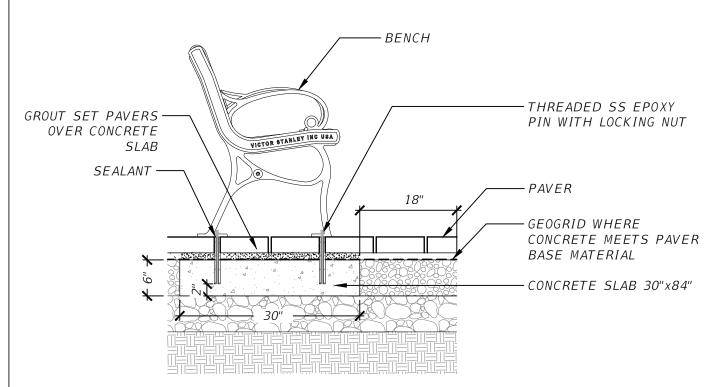

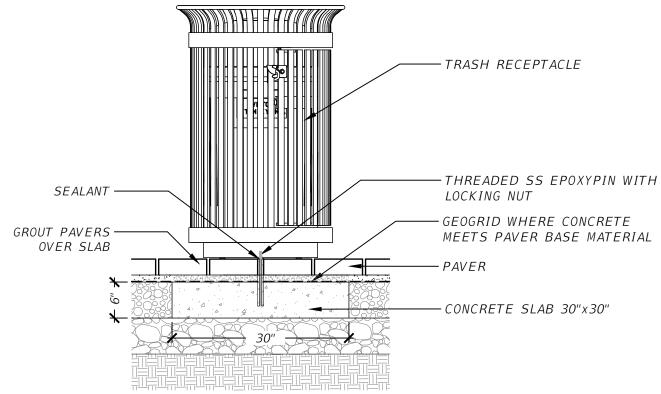

1 BE

## BENCH MOUNTING DETAIL

3/4'' = 1'-0''



## TRASH RECEPTACLE MOUNTING DETAIL

3/4'' = 1'-0''


	REVIS	5 I O N S		DAVID R. CONNER, RLA
DATE	DESCRIPTION	DATE	DESCRIPTION	LA0001327
				DAVID CONNER + ASSOCIATES
				100 E. MADISON ST, SUITE 200
				TAMPA, FL 33602
				CERT. OF AUTHORIZATION LC0000319


	CITY OF TAM MOBILITY DEPAR		
ROAD NO.	COUNTY	FINANCIAL PROJECT ID	ı
	HILLSBOROUGH		

SHEET NO.

LD-11

stensland 9/27/2021 2:0

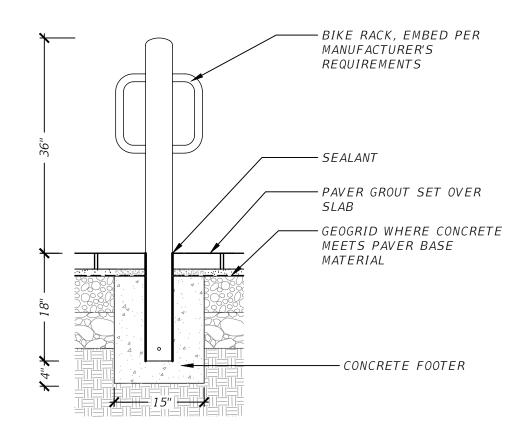

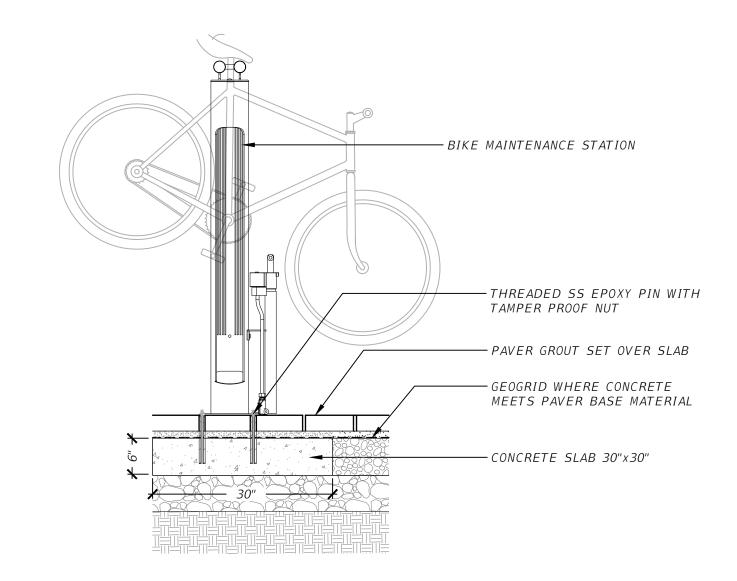

BIKE RACK MOUNTING DETAIL

3/4'' = 1'-0''

BIKE MAINTENANCE STATION MOUNTING DETAIL

3/4" = 1'-0"

DCA-GR-33


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DATE	DESCRIPTION	DATE	DESCRIPTION	LA0001327  DAVID CONNER + ASSOCIATES  100 E. MADISON ST, SUITE 200  TAMPA, FL 33602  CERT. OF AUTHORIZATION LC0000319	RO


CITY OF TAMPA MOBILITY DEPARTMENT								
ROAD NO.	COUNTY	FINANCIAL PROJECT ID						
	HILLSBOROUGH							


HARDSCAPE DETAILS (4)


LD-12

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 $\cdot$  DO NOT HEAVILY PRUNE THE TREE AT PLANTING. PRUNE ONLY CROSSOVER LIMBS, CO-DOMINANT LEADERS, AND BROKEN OR DEAD BRANCHES. SOME INTERIOR TWIGS AND LATERAL BRANCHES MAY BE PRUNED AS WELL. DO NOT REMOVE THE TERMINAL BUDS OF BRANCHES THAT EXTEND TO THE EDGE OF THE CROWN. ALL TREES SHALL BE FREE OF OPEN WOUNDS AND WOUNDS SCARS IN THE CLEAR TRUNK AREA

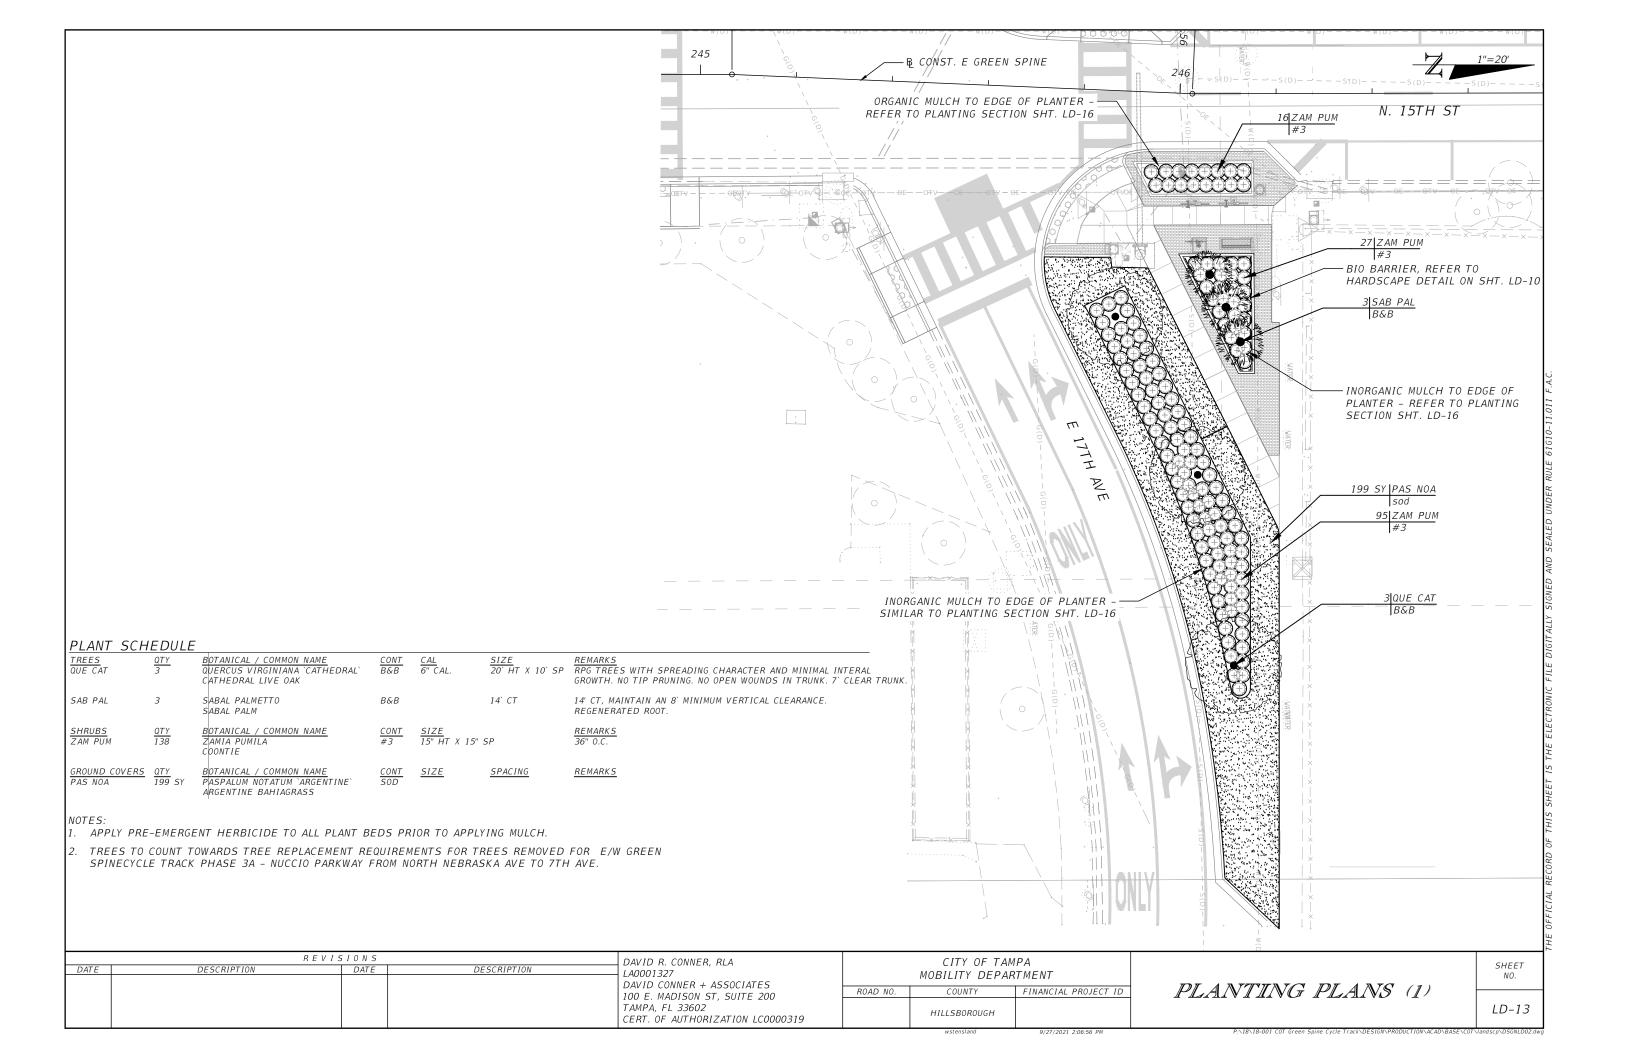REMOVE BURLAP FROM TOP AND TOP 3" PERIMETER OF ROOT BALL. REMOVE ALL STRAPS AND SYNTHETIC BURLAP COMPLETELY. CUT AND REMOVE WIRE BASKET A MIN. DEPT OF 4" BELOW TOP OF ROOT BALL.

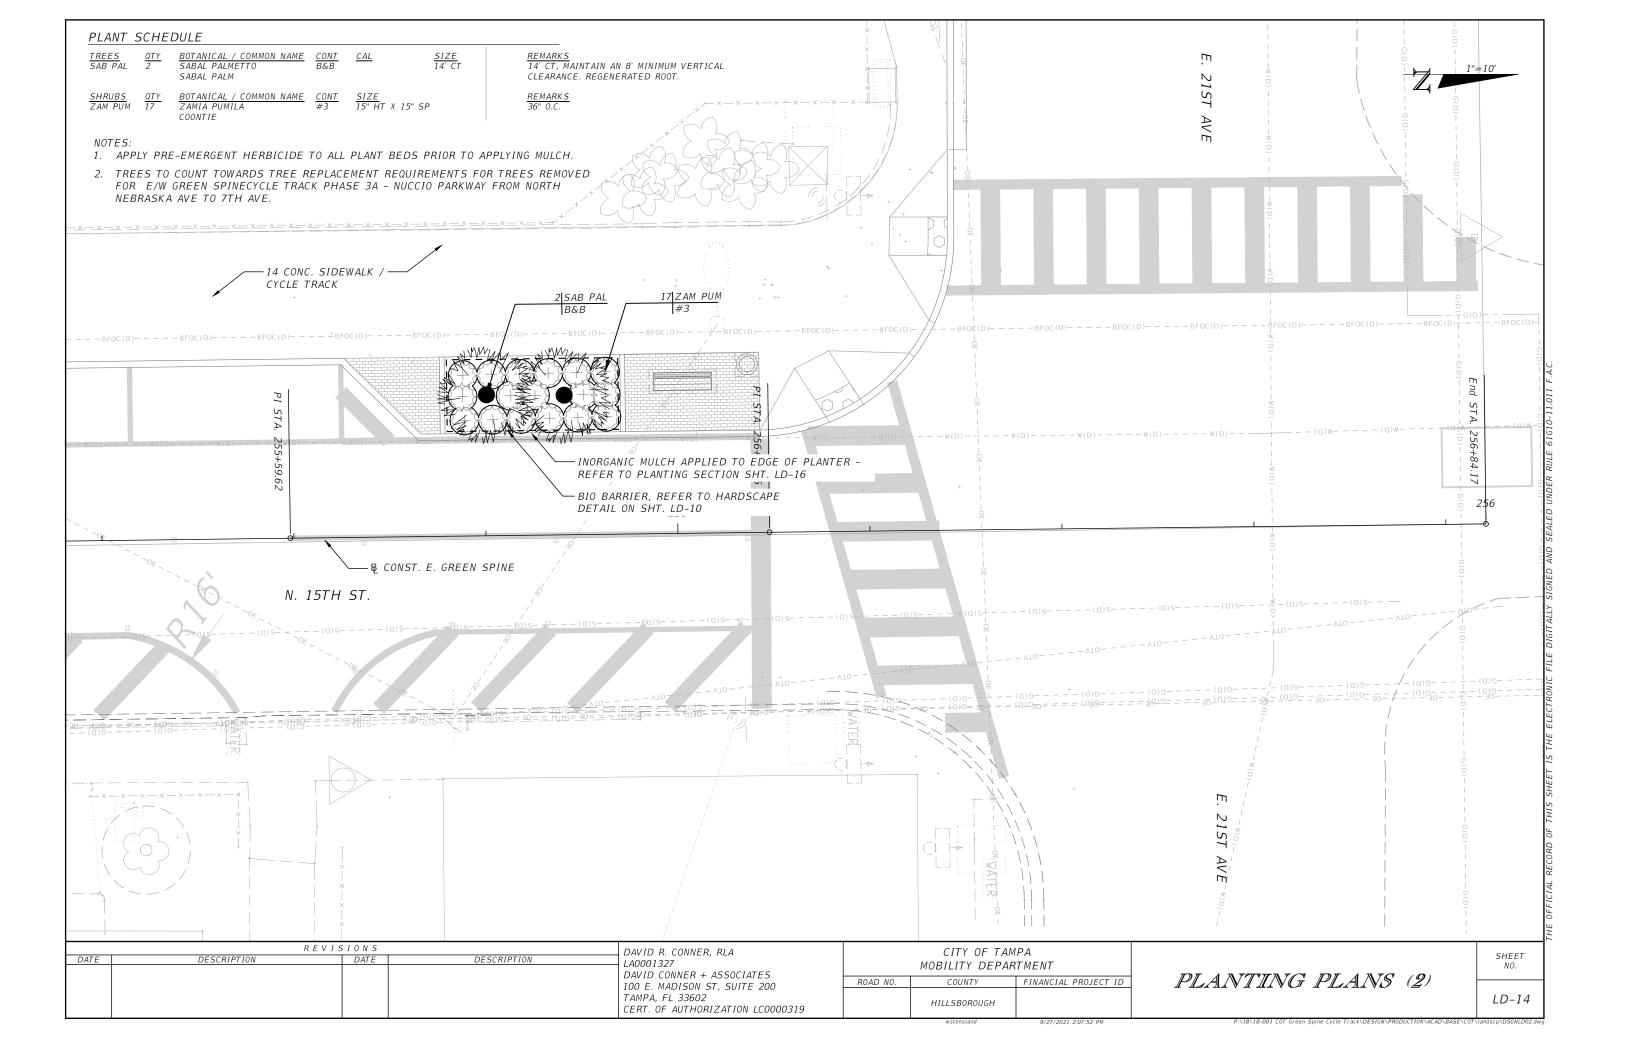FILL SOIL RING WITH 2"-3" DEPTH MULCH. DO NOT ALLOW MULCH TO BE PLACED AGAINST THE TRUNK

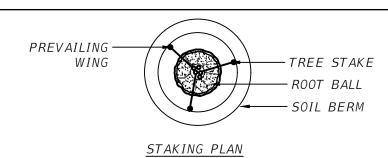ROUND-TOPPED SOIL BERM 4" X 8" WIDE ABOVE ROOT BALL SURFACE CONSTRUCTED AROUND ROOT BALL. BERM SHALL BEGIN AT ROOT BALL PERIPHERY

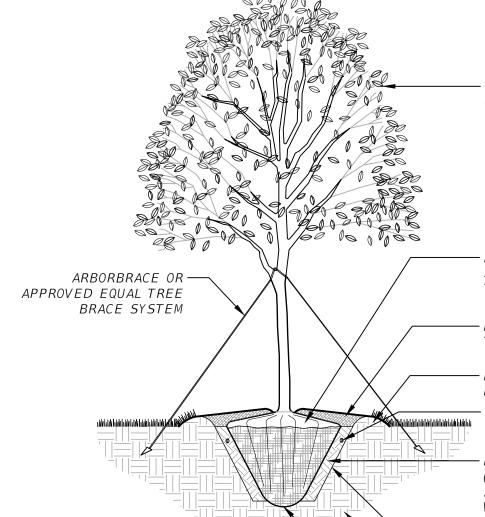-TIME-RELEASE FERTILIZER. PROVIDE TABLET IN QUANITITY RECOMMENDED BY MANUFACTURER FOR SIZE OF TREE.

PLANTING SOIL MIX PER SPECIFICATION BLENDED ONSITE WITH NATIVE SOIL AT 1:2 RATIO (PLANTING SOIL: NATIVE SOIL). LIGHTLY TAMP SOIL AROUND THE ROOT BALL TO REMOVE AIR POCKETS. DO NOT OVER COMPACT. WHEN THE PLANT HOLE HAS BEEN BACKFILLED WATER JET THE PLANTING SOIL TO REMOVE ANY REMAINING AIR POCKETS AND STABALIZE THE ROOTBALL. FILL PLANT RING WITH WATER TO TOP OF PERIMETER SOIL RING AND ALLOW TO PERCOLATE INTO THE SOIL.

-SLOPE SIDES OF SOIL

-EXISTING SOIL

 $\cdot$  PLACE TREE ON UNDISTRURBED BOTTOM OF PIT. WHERE POOR DRAINAGE OR UNDERGROUND WATER IS SUSPECTED CONTACT LANDSCAPE ARCHITECT PRIOR TO INSTALLATION.

#### NOTES:

1) PULL MULCH AWAY FROM TRUNK OF TREE. NO MORE THAN 1" OF MULCH ON TOP OF ROOT BALL. 2) APPLY PRE-EMERENT HERMICIDE TO ALL PLANTING BEDS PRIOR TO APPLYING MULCH.




## LARGE TREE PLANTING


1/4'' = 1'-0''DCA-GR-09

	R	EVISIONS		DAVID R. CONNER, RLA		CITY OF TAN	1PA		CHEET
DATE	DESCRIPTION	DATE	DESCRIPTION	LA0001327 DAVID CONNER + ASSOCIATES		MOBILITY DEPAR	RTMENT		SHEET NO.
				100 E. MADISON ST, SUITE 200	ROAD NO.	COUNTY	FINANCIAL PROJECT ID	PLANTING DETAILS (1)	
				TAMPA, FL 33602 CERT. OF AUTHORIZATION LC0000319		HILLSBOROUGH			LD-15


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DATE	DESCRIPTION DATE	DESCRIPTION	→ DAVID R. CONNER, RLA → LA0001327		CITY OF TA MOBILITY DEPA			SHEET NO.
			DAVID CONNER + ASSOCIATES 100 E. MADISON ST, SUITE 200 TAMPA, FL 33602 CERT. OF AUTHORIZATION LC0000319	ROAD NO.	COUNTY HILLSBOROUGH	FINANCIAL PROJECT ID	PLANTING DETAILS (2)	LD-16
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REVISIONS DAVID R. CONNER, RLA CITY OF TAMPA SHEET DESCRIPTION DATE DESCRIPTION LA0001327 MOBILITY DEPARTMENT DAVID CONNER + ASSOCIATES PLANTING DETAILS (3) FINANCIAL PROJECT ID ROAD NO. COUNTY 100 E. MADISON ST, SUITE 200 TAMPA, FL 33602 LD-17 HILLSBOROUGH CERT. OF AUTHORIZATION LC0000319

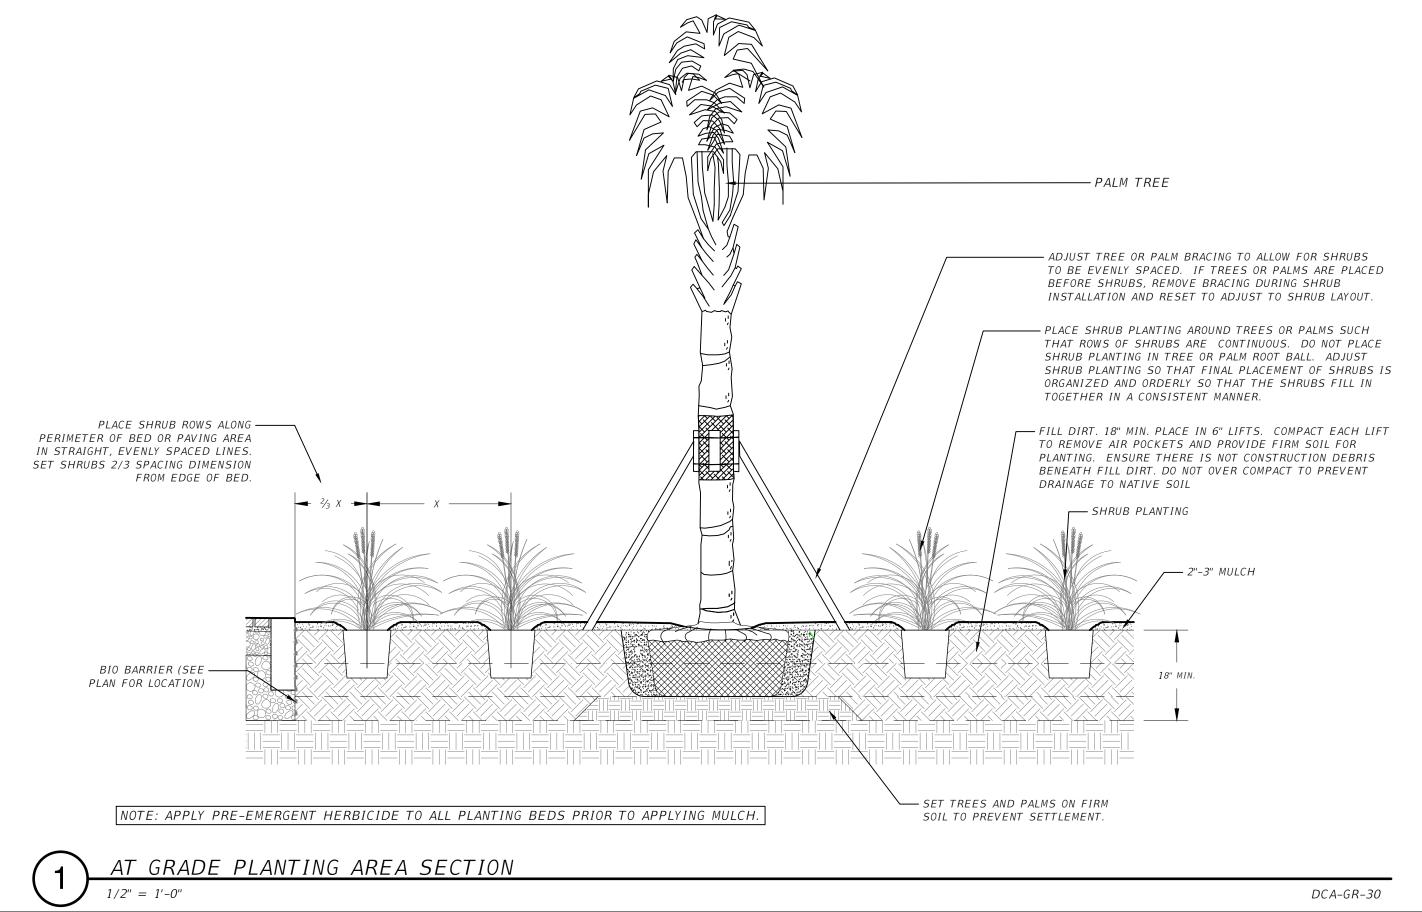

NOTE: APPLY PRE-EMERGENT HERBICIDE PRIOR TO APPLYING MULCH

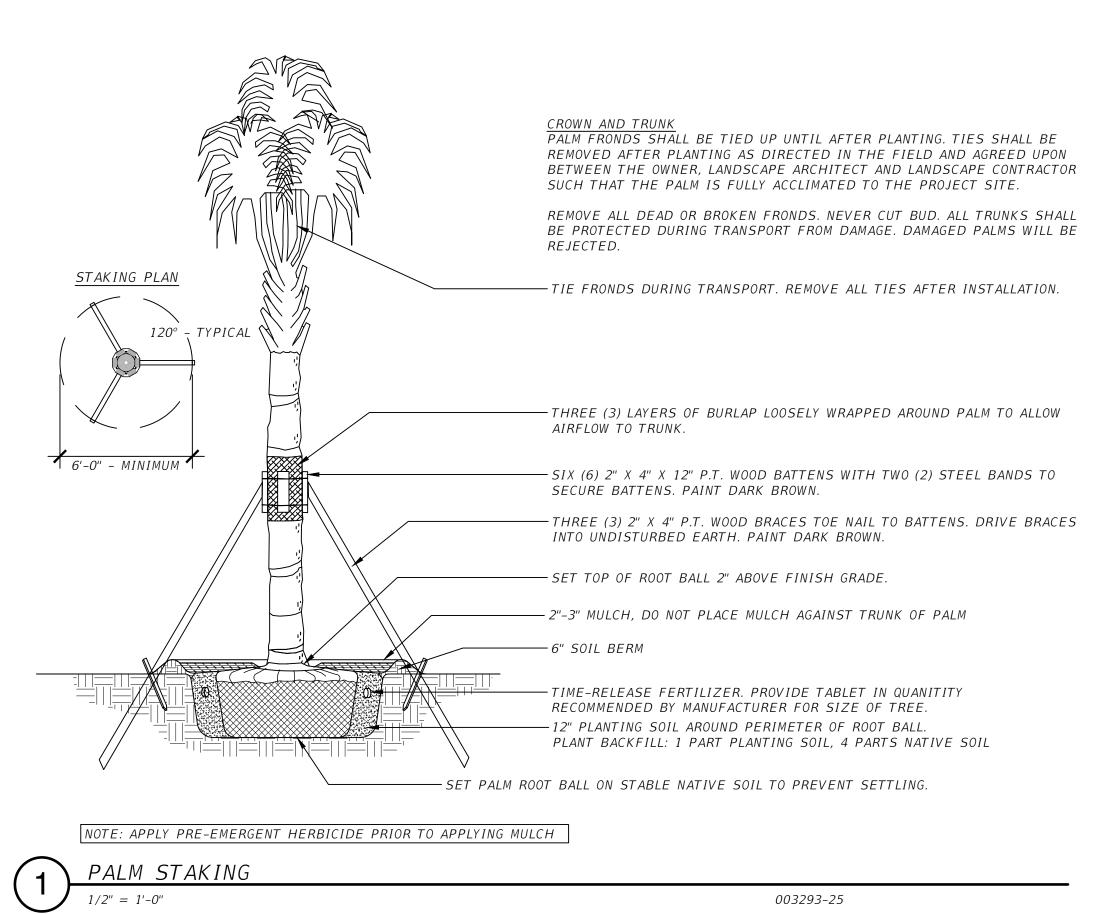SHRUB - MODIFIED SOIL

DCA-GR-06

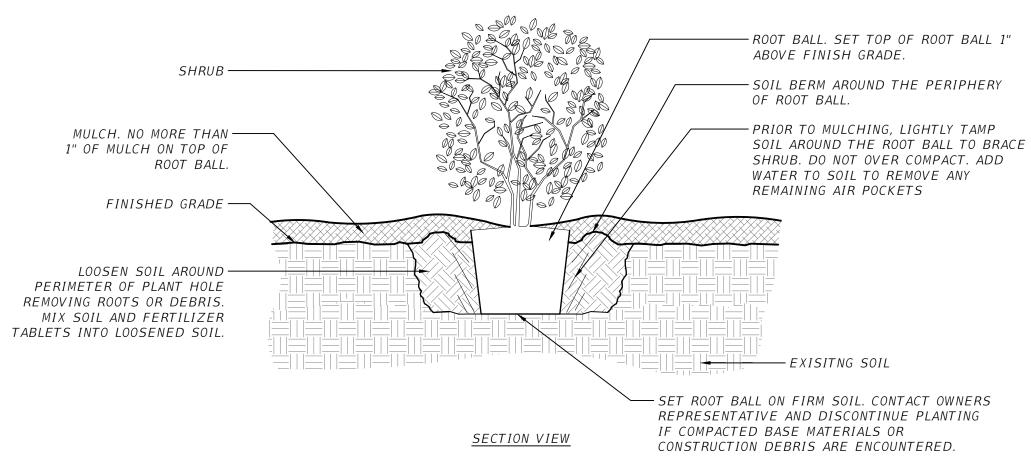		S I O N S		DAVID R. CONNER, RLA		CITY OF TAN	1PA		SHEET
DATE	DESCRIPTION	DATE	DESCRIPTION	LA0001327 DAVID CONNER + ASSOCIATES		MOBILITY DEPAR	RTMENT		NO.
				100 E. MADISON ST, SUITE 200	ROAD NO.	COUNTY	FINANCIAL PROJECT ID	PLANTING DETAILS (4)	
				TAMPA, FL 33602 CERT. OF AUTHORIZATION LC0000319		HILLSBOROUGH			LD-18

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